



Office of Chicago City Clerk



Or2011-582

Office of the City Clerk

City Council Document Tracking Sheet

Meeting Date: 6/8/2011
Sponsor(s): Thomas, Latasha (17)
Type: Order
Title: Issuance of Permit(s) for Sign(s)/Signboard(s) at 122 W
79th St (221 sq. ft.)
Committee(s) Assignment: Committee on Zoning, Landmarks and Building Standards

(signs)

ORDERED, That the Commissioner of Buildings is hereby directed to
issue a sign permit to: (Contractor's name and address)

MODERN Signs Inc
1727 W. ARMITAGE CT.
ADDISON IL. 60101

for the erection of a sign / signboard over 24 feet in height and / or over 100
square feet (in area of one face) at: (Business NAME & ADDRESS)


FORMAN MILLS #100389824
122 W. 79TH ST
CHICAGO IL. 60620

Dimensions: Length 35'11" Height 6'2"

Height above grade / roof to top of sign 2'2"

TOTAL SQUARE FOOT AREA 221 sq FT

Such sign(s) shall comply with all applicable provisions of TITLE 17 of the
Chicago Zoning Ordinance and all other applicable provisions of the Municipal
Code of the City of Chicago governing the construction and maintenance of
outdoor signs, signboards and structures.

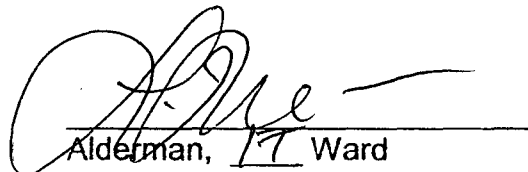
Alderman, 17 Ward



CITY OF CHICAGO

DEPARTMENT OF BUILDINGS

Sign Permit Application

APPROVAL NUMBER B-40197	APPLICATION NUMBER 100389824	ANNUAL FEE	WORK CODE	DRAWINGS ATTACHED <input checked="" type="checkbox"/> YES <input type="checkbox"/> NO				
DATE OF APPLICATION 04/13/2011			TYPE OF SIGN FLAT OR BOX					
ADDRESS OF SIGN 122 W 79TH ST, 60620-			LENGTH	FT. 35	IN. 11	HEIGHT	FT. 6	IN. 2
BUILDING	ORIGINAL PERMIT NUMBER		AREA	SO. FT. 221	WEIGHT		LBS. 200	
TYPE OF PERMIT NEW CONSTRUCTION (SIGN)			SIGN HEIGHT ABOVE GRADE/ROOF			FT. 15		
PAYEE OF ANNUAL INSPECTION STREAHLE, CHRISTOPHER 1450 N CICERO AVE. CHICAGO, IL 60651 (856)910-7122			SHAPE OF SIGN REGULAR					
SIGN MANUFACTURER PHILADELPHIA SIGN CO			SIGN WILL READ CLOTHING FACTORY WAREHOUSE					
ADDRESS WHERE SIGN CAN BE SEEN PRIOR TO ERECTION			NO. OF LAMPS 120		TOTAL WATTAGE 60			
TICKET NUMBER 0			REINSPECTION CONTROL NUMBER		TYPE OF LAMP OTHER			
TYPE OF SUPPORT FOR SIGN BUILDING			NO. OF BALLAST/TRANSFORMERS 2		INPUT OF TRANSFORMERS 120V			
SIGN BOARD SUPPORT MEMBERS STEEL			CONTRACTOR WILL INSTALL		<input checked="" type="checkbox"/> FEEDERS <input checked="" type="checkbox"/> CUSTOMER LEADS			
ANNUAL FEE _____			TYPE OF SWITCH KNIFE					
CONSTRUCTION FEE <u>200.00</u>			LOCATION OF SWITCH LISTED FLUSH TOGGLE					
1017 B FEE _____			SIGN LOCATION TO INSTALL CLOTHING FACTORY WAREHOUSE LETTERS ON WALL					
TOTAL FEE <u>200.00</u>								
AMOUNT PAID <u>200.00</u>								
BALANCE DUE _____								
Check # for Zoning								
Check # for DCAP								

The undersigned certify that the statements in this application are true and correct and that all work done under the proposed permit will conform to the requirements of the Chicago Municipal Code

	REG NO. E12960		BOND NO.	REG NO. N93883
ELECT CONTK LEROY ELECTRIC, INC.	ELECTR	SIGN ERECTOR MODERN SIGNS INC	SIGNER	
ADDRESS P.O. BOX 553 MEDINAH, IL 60157-0553		ADDRESS 1727 ARMITAGE CT ADDISON IL, 60101-		
SUPERVISOR SIGNATURE		SIGNATURE		

The permit issued on this application will authorize only signs here applied for. If other signs are to be erected they must be covered by additional permits

City of Chicago
Richard M. Daley, Mayor



Department of Buildings
Richard Monocchio, Commissioner


TYPE OF BUSINESS OTHER Other: CLOTHING RETAIL Name: FORMAN MILLS LIC #: _____ Renewal Date: _____	SIGN BOND REQUIRED? <input checked="" type="checkbox"/> YES COUNCIL ORDER REQUIRED <input checked="" type="checkbox"/> YES IS SPECIAL PERMISSION REQUIRED FROM CHIEF ELECTRICAL <input type="checkbox"/> YES IF YES, ATTACH LETTER OF REQUEST				
Projects Over: <input checked="" type="checkbox"/> Private Property <input checked="" type="checkbox"/> Public Way Gram Permit #: _____ <input type="checkbox"/> Planned Development/Manufacturing PMD/PD#: _____ Zoning District: OTHER Other: PD338	TIME STAMP				
TYPE OF SIGN: <input type="checkbox"/> ADVERTISING <input checked="" type="checkbox"/> ILLUMINATE <input type="checkbox"/> MOVEABLE <input checked="" type="checkbox"/> BUSINESS <input type="checkbox"/> FLASHING					
TOTAL STREET FRONTAGE OF LOT (IN FEET) <u>493</u> TOTAL AREA OF NEW SIGN (SQ.FT.) <u>221</u> TOTAL AREA OF ALL SIGNS ON LOT (SQ.FT.) <u>261</u> HEIGHT OF SIGN ABOVE GRADE (10 TOP) <u>21ft 2in</u>					
DISTANCE OF CURB LINE OUTER EDGE (ft) <u>199</u> DISTANCE OF STRUCTURE INNER EDGE (ft) <u>200</u>	<table border="1" style="width:100%; border-collapse: collapse;"> <tr> <td style="width:70%;">SIGN CLERK</td> <td style="width:30%;">APPROVED FOR PERMIT</td> </tr> <tr> <td style="height: 40px;"> </td> <td> </td> </tr> </table>	SIGN CLERK	APPROVED FOR PERMIT		
SIGN CLERK	APPROVED FOR PERMIT				
DISTANCE FROM (ft): A. PUBLIC PARK (OVER 10 ACRES) _____ B. EXPRESSWAY (IF LESS THAN 1,000 FT.) _____ C. RESIDENCE DISTRICT (ADVERTISING SIGNS ONLY) _____ IF REPLACEMENT SIGN OR CHANGE OF FACE, WHAT DOES THE EXISTING SIGN READ? Original Payee: _____ Landmark Hold: <input type="checkbox"/> Status: _____	REMARKS				
ZONING (OFFICE USE ONLY)					

CITY OF CHICAGO
DEPARTMENT OF ZONING AND LAND USE PLANNING
SIGN SITE PLAN
(ALL INFORMATION MUST BE COMPLETED AND LEGIBLE)

Site Address: 122 W. 79TH STREET. 3 of 4 applications

Sign Company: MODERN SIGNS INC Rep Name: BILL LEAHY

Phone (224) 402 - 8622 EXT _____ (Below: Building, streets and location of sign on lot or structure)
 North

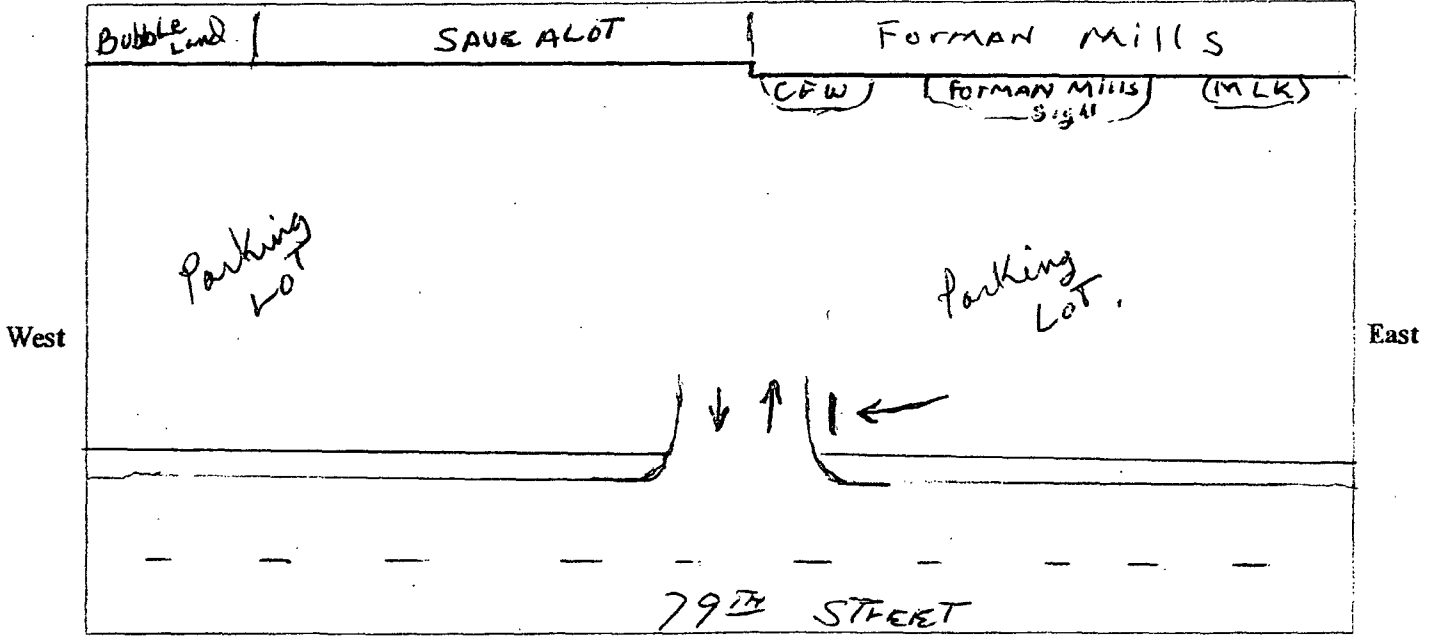

SIGN USE:
 Bus. ID (On-premise)
 Business Lice. # _____
 Advertising (Off-premise)

TYPE OF SIGN:
 Flat Wall
 Freestanding
 Awning
 Marquee
 High Rise Building
 Projecting Private
 Projecting Public Way
 Public Way Use -Permit # _____

SIGN CHARACTERISTICS:
 Non- Illuminated
 Illuminated
 Changing Image
 Video Display
 Flashing

PERMIT TYPE:
 New Construction
 Change of Face _____
 Previous Permit #


DISTANCE FROM:
 Curb Line: 200'
 Expressway, Toll Roads or Major Route _____
 (n/a if over 1000 ft) _____
 Park (over 10 acres) _____
 Residential Zone _____
 Existing Off-premise on same side of street: _____

TOTAL SQUARE FOOTAGE:
 Square footage of this proposed sign 221
 Gross area of all proposed signs 680
 Area of all existing signs _____
 (not including proposed) on Zoning Lot 261

Signature: William T. Leahy


Date: 4-18-2011

ENGINEERING
SHOP
VINYL / LAYOUT
ROUTING / KNIIFE

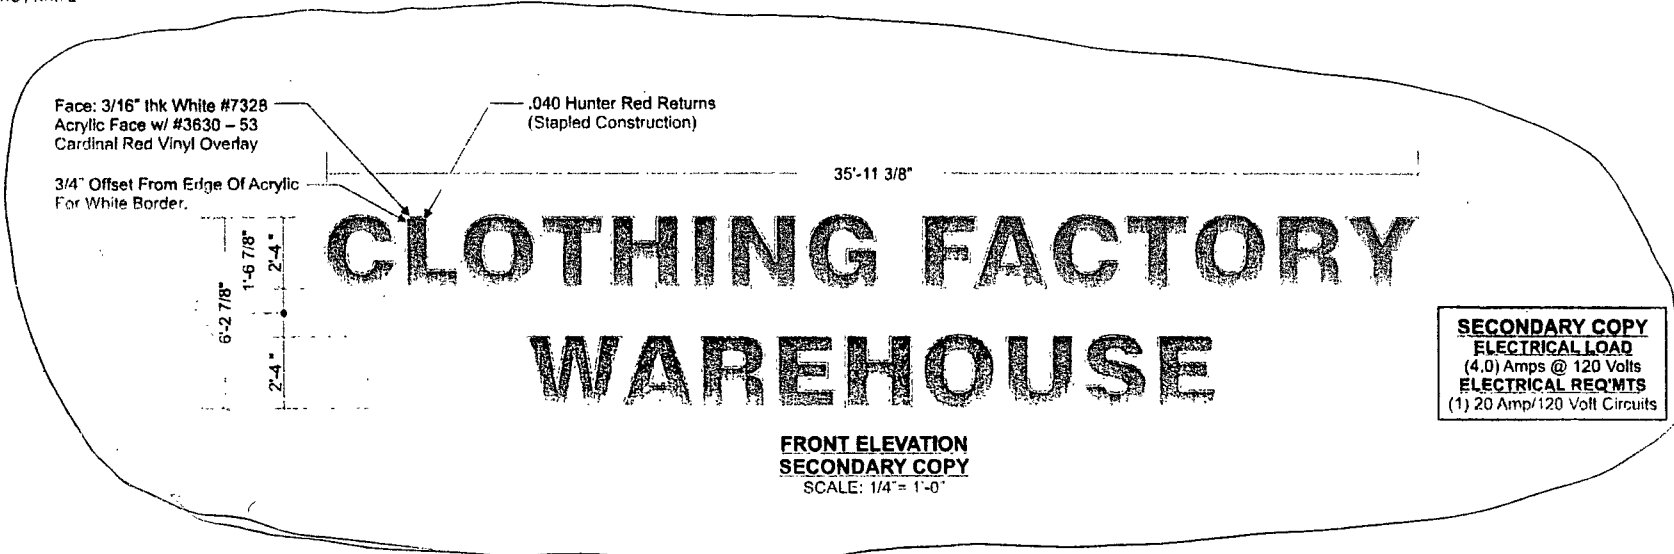

SECONDARY COPY
ELECTRICAL LOAD
(4.0) Amps @ 120 Volts
ELECTRICAL REQ'MTS
(1) 20 Amp/120 Volt Circuits

FRONT ELEVATION
SECONDARY COPY
SCALE: 1/4" = 1'-0"

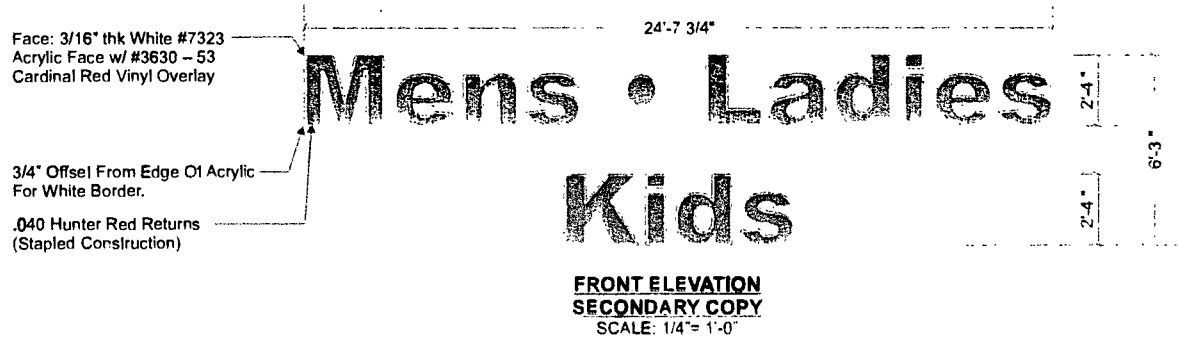

SECONDARY COPY
ELECTRICAL LOAD
(2.0) Amps @ 120 Volts
ELECTRICAL REQ'MTS
(1) 20 Amp/120 Volt Circuits

FRONT ELEVATION
SECONDARY COPY
SCALE: 1/4" = 1'-0"

**PERMITS
ONLY**

Note: This sign is intended to be installed in accordance with the requirements of Article 600 of the National Electrical Code and/or other applicable local codes. This includes proper grounding and bonding of the sign.


- STANDARD LETTER NOTES:**
1. Sufficient Primary Circuit In Vicinity Of Sign By Others.
 2. Letter To Letter Wiring & Final Primary Hook-up By Sign Installer, Where Allowed By Local Codes.
 3. Sign Shall Be U.L. Listed.
 4. Mounting Hardware By Sign Installer.
 5. Full Size Drilling Template Furnished With Sign.

**Philadelphia Sign
COMPANY**
707 West Spring Garden Street
Palmyra, New Jersey 08067
Phone: 610-891-1220
Fax: 610-891-5300
E-mail: phil@philadelphia-sign.com


CUSTOMER:	FORMAN MILLS
JOB NUMBER:	FM017
SIGN TYPE:	Various
LOCATION:	122 West 79th St Chicago, IL
DATE:	03/16/2011
DRAWN BY:	JLTH
REVISION:	Number Date By
SHEET:	2 OF 5 PNO DEPT
DWG NUMBER:	B-40197
ENGINEER SEAL:	

MAX DESIGN WIND SPEED 50 MPH
MAX DESIGN WIND LOAD 30 LBS/SQ. FT
EXPOSURE C
THIS IS AN ORIGINAL UNPUBLISHED DRAWING CREATED BY PSCN. IT IS SUBMITTED FOR YOUR PERSONAL USE IN CONNECTION WITH A PROJECT BEING PREPARED FOR YOU BY PSCN. IT IS NOT TO BE SHOWN TO ANYONE OUTSIDE YOUR ORGANIZATION NOR IS IT TO BE REPRODUCED, COPIED, OR TRANSMITTED IN ANY FORM OR BY ANY MEANS.

ENGINEERING
SHOP
VINYL / LAYOUT
ROUTING / CUT

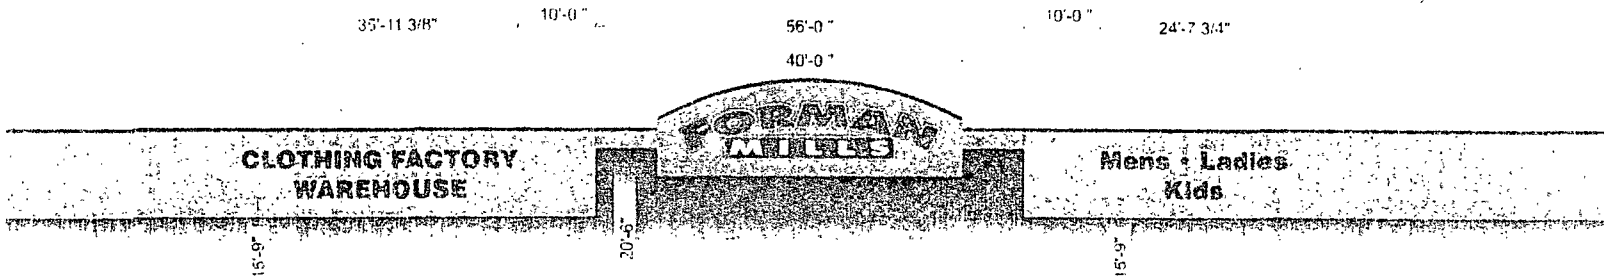

BUILDING ELEVATION
SCALE: 1/16" = 1'-0"

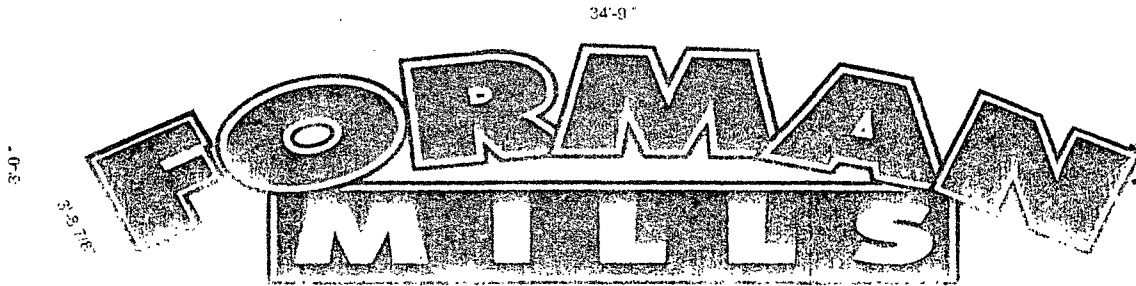

FRONT ELEVATION
SCALE: 1/4" = 1'-0"

Face: 3/16" blk White #7321
Acrylic Face w/ #3630 - 53
Cardinal Red Vinyl Overlay

.063 Hunter Red Returns
(Stapled Construction)

**PERMITS
ONLY**

**PRIOR TO FABRICATION
FIELD VERIFICATION
IS REQUIRED**

STANDARD LETTER NOTES:

1. Sufficient Primary Circuit In Vicinity Of Sign By Others.
2. Letter To Letter Wiring & Final Primary Hook-up By Sign Installer, Where Allowed By Local Codes.
3. Sign Shall Be U.L. Listed.
4. Mounting Hardware By Sign Installer.
5. Full Size Drilling Template Furnished With Sign.

FORMAN LETTERS
ELECTRICAL LOAD
(5.0) Amps @ 120 Volts
ELECTRICAL REQ'MTS
(1) 20 Amp/120 Volt Circuits

MILLS WALL SIGN
ELECTRICAL LOAD
(13.64) Amps @ 120 Volts
ELECTRICAL REQ'MTS
(1) 20 Amp/120 Volt Circuits

Note: This sign is intended to be installed in accordance with the requirements of Article 609 of the National Electrical Code and/or other applicable local codes. This does not preclude grounding and bonding of the sign.



**Philadelphia Sign
COMPANY**

207 West Spring Garden Street
Philadelphia, New Jersey 08103

Phone: (610) 426-1111
Fax: (610) 426-1112
E-mail: info@psign.com

CUSTOMER:
FORMAN MILLS

JOB NUMBER:
FM017

SIGN TYPE:
Various

LOCATION:
122 West 79th St
Chicago, IL

DATE:
03/16/2011

DRAWN BY:
JLTH

REVISION
Number Date By

SHEET
1 OF 5

DWG NUMBER:
B-40197

ENGINEER SEAL

MAX DESIGN WIND SPEED 90 MPH
MAX DESIGN WIND LOAD 20 LBS SQ. FT
EXPOSURE C

ENGINEERING
SHOP
VINYL / LAYOUT
ROUTING / KNIFE

Designated Primary Power Run To
Vicinity Of Sign w/a Lockable Disconnect
Switch For Service - (By Others)

#8 x 1/2" Pan head Screws Painted
To Match Returns

Letter Trim Cap To Be Jewelite 1"
Red

Letter Returns to Be .040 Alum.
Exterior To Be Painted Hunter Red

Return Stapled To Letter Backs

Face: 3/16" thk White #7328
Acrylic Face w/ #3630-53 Cardinal
Red Vinyl Overlay

Sloan Modular 60 Pnwr Supply 12VDC

7/8" Dia 2" Lg Coupling

7/8" Chase Nipple


Sloan Value Line White Long Modules

Letter Backs to Be .050 Precoat White Alum.
Interior to Be Painted Spray-Lat
Starbrite White (Light Enhancement Paint)

3/8" Dia Allthread Rod w/3/8" Thk
Nylon Spacer, 3/8" Dia Fender Washer
And Nut Secured on Backside Of Fascia

3/8" Dia Nutsert

Drain Holes In Back Of Letters
As Req'd

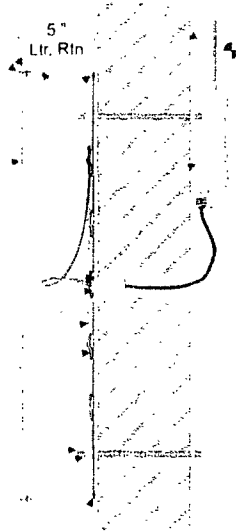

SECONDARY COPY SECTION
SCALE: 1-1/2" = 1'-0"

**PERMITS
ONLY**

**PRIOR TO FABRICATION
FIELD VERIFICATION
IS REQUIRED**

#8 x 1/2" Pan head Screws Painted
To Match Returns

Letter Trim Cap To Be Jewelite 1"
Red

Letter Returns to Be .063 Alum.
Exterior To Be Painted Hunter Red

Return Stapled To Letter Backs

Designated Primary Power Run To
Vicinity Of Sign w/a Lockable Disconnect
Switch For Service - (By Others)

Face: 3/16" thk White #7328
Acrylic Face w/ #3630-53 Cardinal
Red Vinyl Overlay

Sloan Modular 60 Power Supply 12VDC

7/8" Dia 2" Lg Coupling

7/8" Chase Nipple

.063" Thk White Precoat Aluminium
Insert Panel

Sloan Value Line White Long Modules


Fabricated "Z" Bracket

Letter Backs to Be .063 Precoat White Alum.
Interior To Be Painted Spray-Lat
Starbrite White (Light Enhancement Paint)

3/8" Dia Allthread Rod w/3/8" Thk
Nylon Spncor, 3/8" Dia Fender Washer
And Nut Secured on Backside Of Fascia

3/8" Dia Nutsert

Drain Holes In Back Of Letters
As Req'd

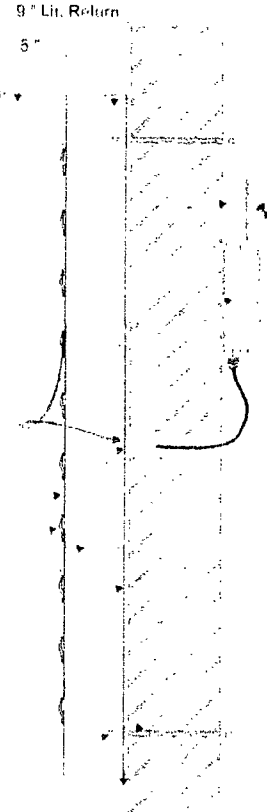

FORMAN LETTERS SECTION
SCALE: 1-1/2" = 1'-0"

STANDARD LETTER NOTES:

1. Sufficient Primary Circuit In Vicinity Of Sign By Others.
2. Letter To Letter Wiring & Final Primary Hook-up By Sign Installer, Where Allowed By Local Codes.
3. Sign Shall Be U.L. Listed.
4. Mounting Hardware By Sign Installer.
5. Full Size Drilling Template Furnished With Sign.

**FORMAN LETTERS
ELECTRICAL LOAD
(5.0) Amps @ 120 Volts
ELECTRICAL REQ'MTS
(1) 20 Amp/120 Volt Circuits**

**Philadelphia Sign
COMPANY**
707 West Spring Garden Street
Philadelphia, New Jersey 08107

CUSTOMER:
FORMAN MILLS

JOB NUMBER:
FM017

SIGN TYPE:
Various

LOCATION:
**122 West 79th St
Chicago, IL**

DATE:
03/16/2011

DRAWN BY:
JLTH

REVISION:
Number Date By

SHEET: 4 OF 5

DWG NUMBER:
B-40197

ENGINEER SEAL:

MAX DESIGN WIND SPEED 90 MPH
MAX DESIGN WIND LOAD 30 LBS/ SQ FT
EXPOSURE C

THIS IS AN ORIGINAL ENGINEERING DRAWING. IT SHALL BE MAINTAINED IN THE SIGN INSTALLER'S OFFICE AND SHALL BE PROTECTED FROM UNAUTHORIZED REPRODUCTION OR ALTERATION. THE SIGN INSTALLER SHALL BE RESPONSIBLE FOR OBTAINING ALL NECESSARY PERMITS AND APPROVALS. THE SIGN SHALL BE INSTALLED IN ACCORDANCE WITH ALL APPLICABLE CODES AND STANDARDS. THE SIGN SHALL BE MAINTAINED IN GOOD CONDITION AT ALL TIMES.

Mens - Ladies - Kids

**SECONDARY COPY
ELECTRICAL LOAD
(2.0) Amps @ 120 Volts
ELECTRICAL REQ'MTS
(1) 20 Amp/120 Volt Circuits**

Note: This sign is intended to be installed in accordance with the requirements of Article 610 of the National Electrical Code and/or other applicable local codes. This includes proper grounding and bonding of the sign.