



City of Chicago



Or2015-458

Office of the City Clerk

Document Tracking Sheet

Meeting Date:	7/29/2015
Sponsor(s):	Solis (25)
Type:	Order
Title:	Issuance of permits for sign(s)/signboard(s) at 2800 S Ashland Ave - north elevation
Committee(s) Assignment:	Committee on Zoning, Landmarks and Building Standards

Committee on Zoning, Landmarks
and Building Standards
City Council Meeting
Alderman Daniel S. Solis – Ward 25
Sign Order

ORDERED, That the Commissioner of Buildings is hereby directed to issue a sign permit to:

Landmark Sign Group
7424 Industrial Ave.
Chesterton, IN 46304

For the erection of a sign/signboard over 24 feet in height and/or over 100 square feet (in area of one face) at:

QTS
2800 s. Ashland Ave.
Chicago, IL 60608

Dimensions: length 26'-11" height 14'

Height above grade/roof to top of sign 56'-6" feet

Total Square Foot Area 377 square feet

Elevation North (Permit #100602162)

Such sign shall comply with all applicable provisions of TITLE 17 of the Chicago Zoning Ordinance and all other applicable provisions of the Municipal Code of the City of Chicago governing the construction and maintenance of outdoor signs, signboards and structures.



Alderman Daniel S. Solis
Ward 25



7424 Industrial Avenue
 Chesterton, IN 46504
 Phone 219.762.9577
 Fax 219.762.4259
 www.landmarksign.com

PRINT #
RB-22038-2
RANDY BENNETT
 L&C SALES REPRESENTATIVE

12.03.14
 DATE

QTS
 CLIENT NAME

2800 S. ASHLAND
 CHICAGO, IL
 JOB LOCATION

1/4" = 1'-0"
 SCALE


REVISIONS:
 1. ADD NEW LOGO
 06.10.15 JL
 2. ADD HIT TO GRADE
 06.22.15 JL

Designed for 110 volts
 Electrical Connection will be visible within 8 ft. at time of installation.
 Second Time Installation in Chicago at Time & Material


THIS DRAWING IS THE PROPERTY OF LANDMARK SIGN GROUP, INC. NO PART OF THIS DRAWING IS TO BE REPRODUCED OR TRANSMITTED IN ANY FORM OR BY ANY MEANS, ELECTRONIC OR MECHANICAL, WITHOUT THE WRITTEN PERMISSION OF LANDMARK SIGN GROUP, INC.

By signing the Customer Acceptance on this print, I understand that I am accepting all aspects of this drawing. This includes: Artwork, Specifications, Dimensions, Spelling, and all other representations herein. I also understand that color reproductions on this print are approximate, and may not match manufacturer's samples exactly.

DATE: _____ IF REQUIRED, Lender's Acceptance & SIGNATURE: _____ DATE: _____ U.S.G. SALES INITIALS: _____ DATE: _____

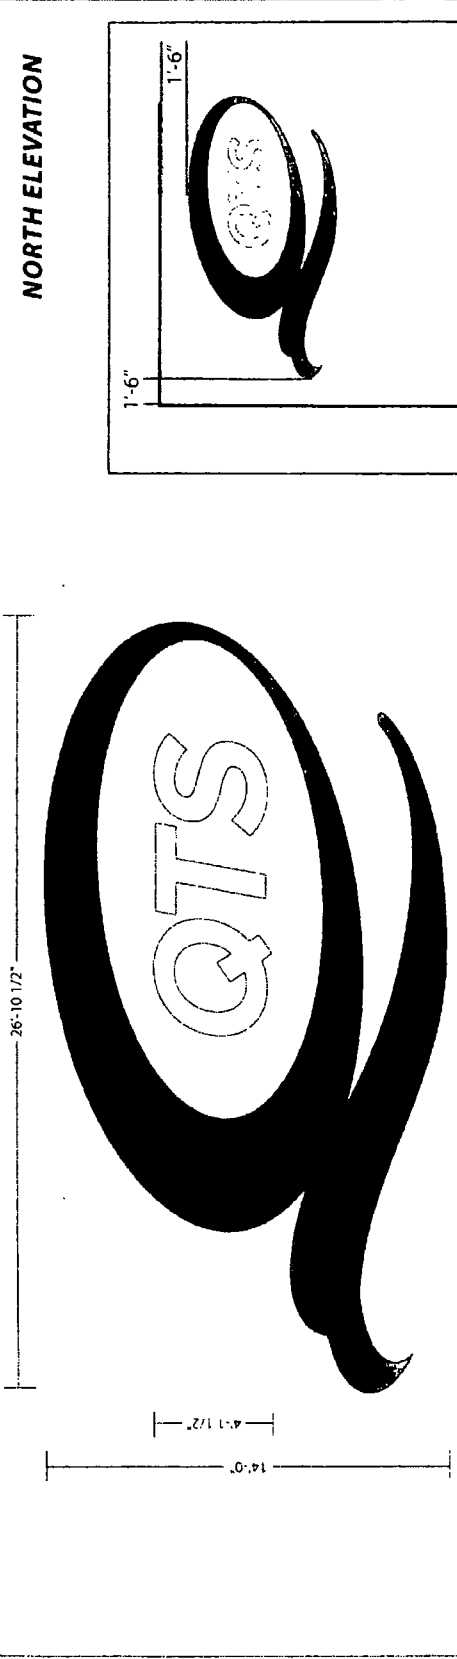

NORTH ELEVATION

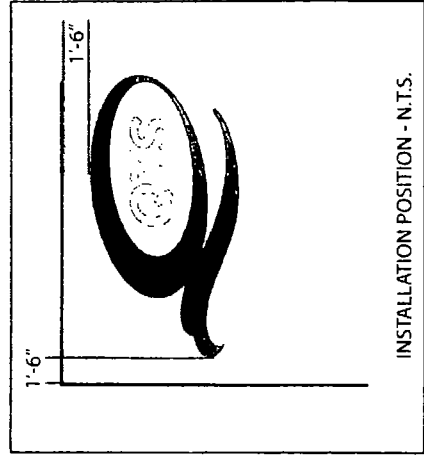



INSTALLATION POSITION - N.T.S.

TOTAL WEIGHT = 528 LBS

- ▶ ONE SET OF 5" DEEP FABRICATED ALUMINUM LETTERS/ EXTERIOR PAINT/ MOUNT TO GROOVED METAL WALL
- ▶ ILLUMINATION WITH FLOOD LIGHTING TO BE PROVIDED BY OTHERS

O LOGO FACE & 5" RETURNS = MP23966 CRIMSON RED
 QTS LETTER FACES & 5" RETURNS = MAP WHITE


Make: cooper lighting
 Type: 400-watt, HID
 UMH, MS9 lamp
 Voltage: Multi tap bullets,
 Set up for 277v.
 Three total per wall

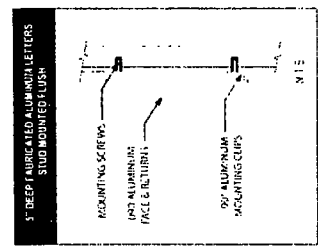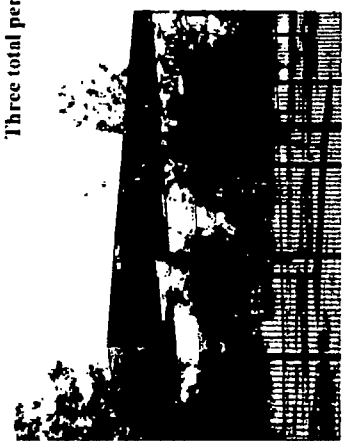

42'-6" to Grade

PROPOSED - N.T.S.

EXISTING - N.T.S.

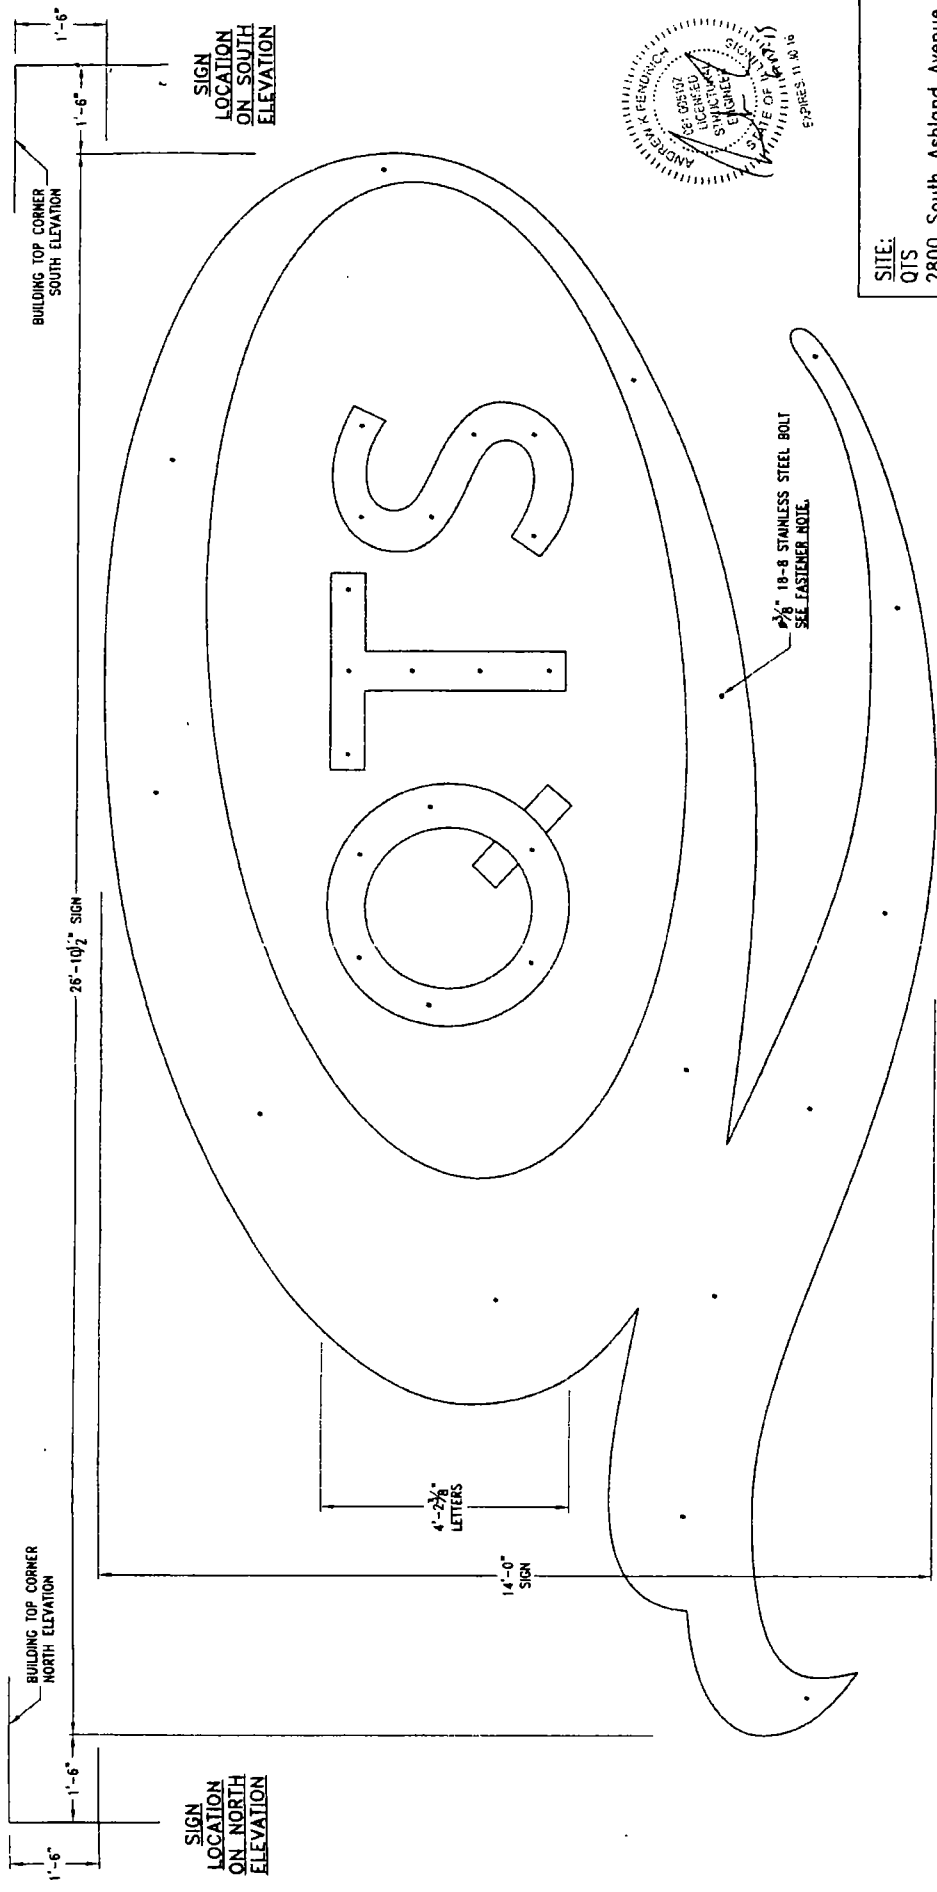

SITE:
 QTS
 2800 South Ashland Avenue
 Chicago, Illinois

REV.	DATE	RELEASED FOR PERMITTING	DESCRIPTION	APPROVED
A	15 Jun 15	J. HOGAN		

Robert-James & Associates, Inc.
 12255 West 187th Street, Mokena Illinois 60448-9737
 phone: 708-479-8395 Fax: 708-479-8395 email: rj@comcast.net

NON-ILLUMINATED LOGO AND LETTERS
(2) SETS MOUNTED TO BUILDING WALLS

DATE	BY	SCALE	DRAWING NUMBER	SHEET	REV.
15 Jun 15	D. MURKS	NONE	1506066	1	A
15 Jun 15	J. HOGAN				

ELEVATION VIEW

NOTE: (2) SIGNS TO BE INSTALLED ON BUILDING AT THIS SITE (SEE LOCATIONS ABOVE)

DESIGN WIND LOAD: 30.0 PSF
 Based on the Chicago Building Code Table 16 (13-52-310) (1) 1a.

DESIGN SNOW LOAD: 25.0 PSF
 Based on the Chicago Building Code 16 (13-52-280) (a) for flat roofs.

FASTENER NOTE:
 Use 18-8 stainless steel bolts as listed:
 TEK screws in metal studs.
 Toggle bolts in 1/2" plywood sheathing between studs.