



City of Chicago



O2016-6841

Office of the City Clerk

Document Tracking Sheet

Meeting Date:	9/14/2016
Sponsor(s):	Laurino (39)
Type:	Ordinance
Title:	Grant(s) of privilege in public way for Huntington National Bank
Committee(s) Assignment:	Committee on Transportation and Public Way

ORDINANCE
HUNTINGTON NATIONAL BANK
Acct. No. 408115 - 1
Permit No. 1123927

Be It Ordained by the City Council of the City of Chicago:

SECTION 1. Permission and authority are hereby given and granted to HUNTINGTON NATIONAL BANK, upon the terms and subject to the conditions of this ordinance to maintain and use one (1) sign(s) projecting over the public right-of-way attached to its premises known as 4012 N. Pulaski Rd..

Said sign structure(s) measures as follows; along N PULASKI RD:

One (1) at seventeen point six seven (17.67) feet in length, three point four two (3.42) feet in height and twelve (12) feet above grade level.

The location of said privilege shall be as shown on prints kept on file with the Department of Business Affairs and Consumer Protection and the Office of the City Clerk.

Said privilege shall be constructed in accordance with plans and specifications approved by the Department of Transportation (Division of Project Development) and Zoning Department - Signs.

This grant of privilege in the public way shall be subject to the provisions of Section 10-28-015 and all other required provisions of the Municipal Code of Chicago.


The grantee shall pay to the City of Chicago as compensation for the privilege #1123927 herein granted the sum of three hundred (\$300.00) per annum in advance.

A 25% penalty will be added for payments received after due date.

The permit holder agrees to hold the City of Chicago harmless for any damage, relocation or replacement costs associated with damage, relocation or removal of private property caused by the City performing work in the public way.

Authority herein given and granted for a period of five (5) years from and after Date of Passage.

Alderman

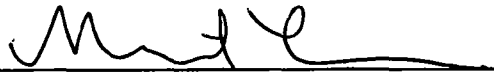

Margaret Laurino 39th Ward

**ENGINEERING
SHOP
VINYL / LAYOUT
ROUTING / KNIFE**


ALL ELECTRICAL WORK TO MEET OR EXCEED
UL REQUIREMENTS
ALL EXPOSED FASTENERS TO BE PAINTED
TO MATCH CABINET
ELECTRICAL LEADS FROM THE BACK OF
ILLUMINATED LETTERS TO BE A MINIMUM OF
8" IF LONG AS MEASURED FROM THE BACK
OF THE LETTER

MATERIAL SPECIFICATIONS

PAINT
GREY/IRON METALLIC MATTHEWS MP11443
LASER LINE GREEN MATTHEWS MP11108
STONEMORE BE VALVIC MATTHEWS MP11268
BLACK MATTHEWS 22585P
WHITE MATTHEWS 42025P

VINYL
TRANSLUCENT WHITE AFLON 8500-20
WHITE DIFFUSER AFLON 8600-20
OPAQUE WHITE AFLON 8200-20
TRANSLUCENT GREEN AFLON 8200-20B2
TRANSLUCENT GREEN AFLON 8200-20B2
PERMANENT GREEN AFLON 8803 Green
GRAY METALLIC AFLON P2160-008

ACRYLIC
WHITE ACRYLIC 7526
WHITE ACRYLIC 7547
CLEAR ACRYLIC

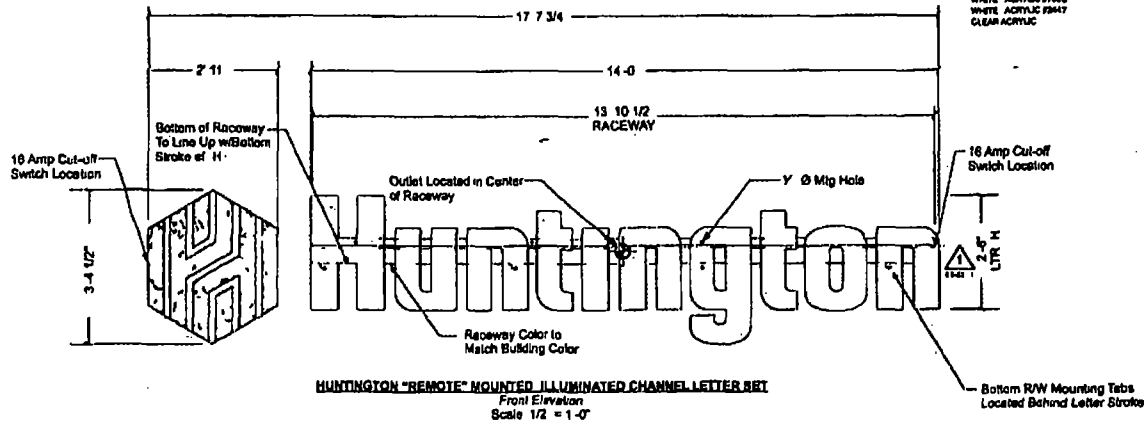

HUNTINGTON "REMOTE" MOUNTED ILLUMINATED CHANNEL LETTER SET
Front Elevation
Scale 1/2" = 1'-0"

P	Philadelphia Sign						
	207 W. 43rd Street, Suite 1000, Indianapolis, IN 46208						
CUSTOMER	HUNTINGTON BANK						
JOB NUMBER	HNT033105						
SIGN TYPE	HNT CLWR_30						
LOCATION	2630 W 86th St Indianapolis, IN						
DATE	2-16-11						
DRAWN BY	JPH						
REVISION	<table border="1"> <thead> <tr> <th>Number</th> <th>Date</th> <th>By</th> </tr> </thead> <tbody> <tr> <td>1</td> <td>02/23/11</td> <td>NCH</td> </tr> </tbody> </table>	Number	Date	By	1	02/23/11	NCH
Number	Date	By					
1	02/23/11	NCH					
SHEET	1 of 3						
DWG NUMBER	B-39865						
ENGINEER SEAL							

- STANDARD LETTER NOTES:**
1. Sufficient Primary Circuit in Vicinity Of Sign By Other
 2. Letter To Letter Wiring & Final Primary Hook-up By Sign Installer. Where Allowed By Local Codes
 3. Sign Shed Be U.L. Listed
 4. Mounting Hardware By Sign Installer
 5. Full Size Drilling Template Furnished With Sign

Note: This sign is intended to be installed in accordance with the requirements of Article 600 of the National Electrical Code and/or other applicable local codes. This includes proper grounding and bonding of the sign.

**CONSTRUCTION
DRAWING**

ELECTRICAL LOAD
(2.37) Amps @ 120 Volts
ELECTRICAL REQUIREMENTS
(1) 20 Amp/120 Volt Circuits

LED Specifications
1 (4) Brite 60W 12V
Power Supplies
2 (220 Each) Brite Optics Pro
Plus Bright White LED Modules

MAX DESIGN WIND SPEED IS 85 MPH
MAX DESIGN WIND LOAD IS 15 LBS/SQ. FT.
EXPOSURE C

This is no original. If published or used
without the permission of the author
the user assumes all liability for any
errors or omissions. This drawing is
intended for use only in the project
described. It is not to be used for
any other project without the
written consent of the author.